

PROJECT: 16763-00034 - 127 WASHINGTON AVENUE, SUITE 203-C, NORTH HAVEN, CT 06473
DATE: 02/24/2025
DRAWN BY: J. L. HARRIS
CHECKED BY: J. L. HARRIS
APPROVED BY: J. L. HARRIS


WOODBIDGE LANDFILL GREENSKIES CLEAN ENERGY, LLC

ACORN HILL ROAD EXD.
WOODBIDGE, CONNECTICUT

SLR #16763.00034
FEBRUARY 24, 2025




PROJECT SITE VICINITY MAP:

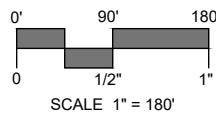

PREPARED BY:



67 HUNT STREET, SUITE 203-C
AGAWAM, MA
413.241.6920
SLRCONSULTING.COM

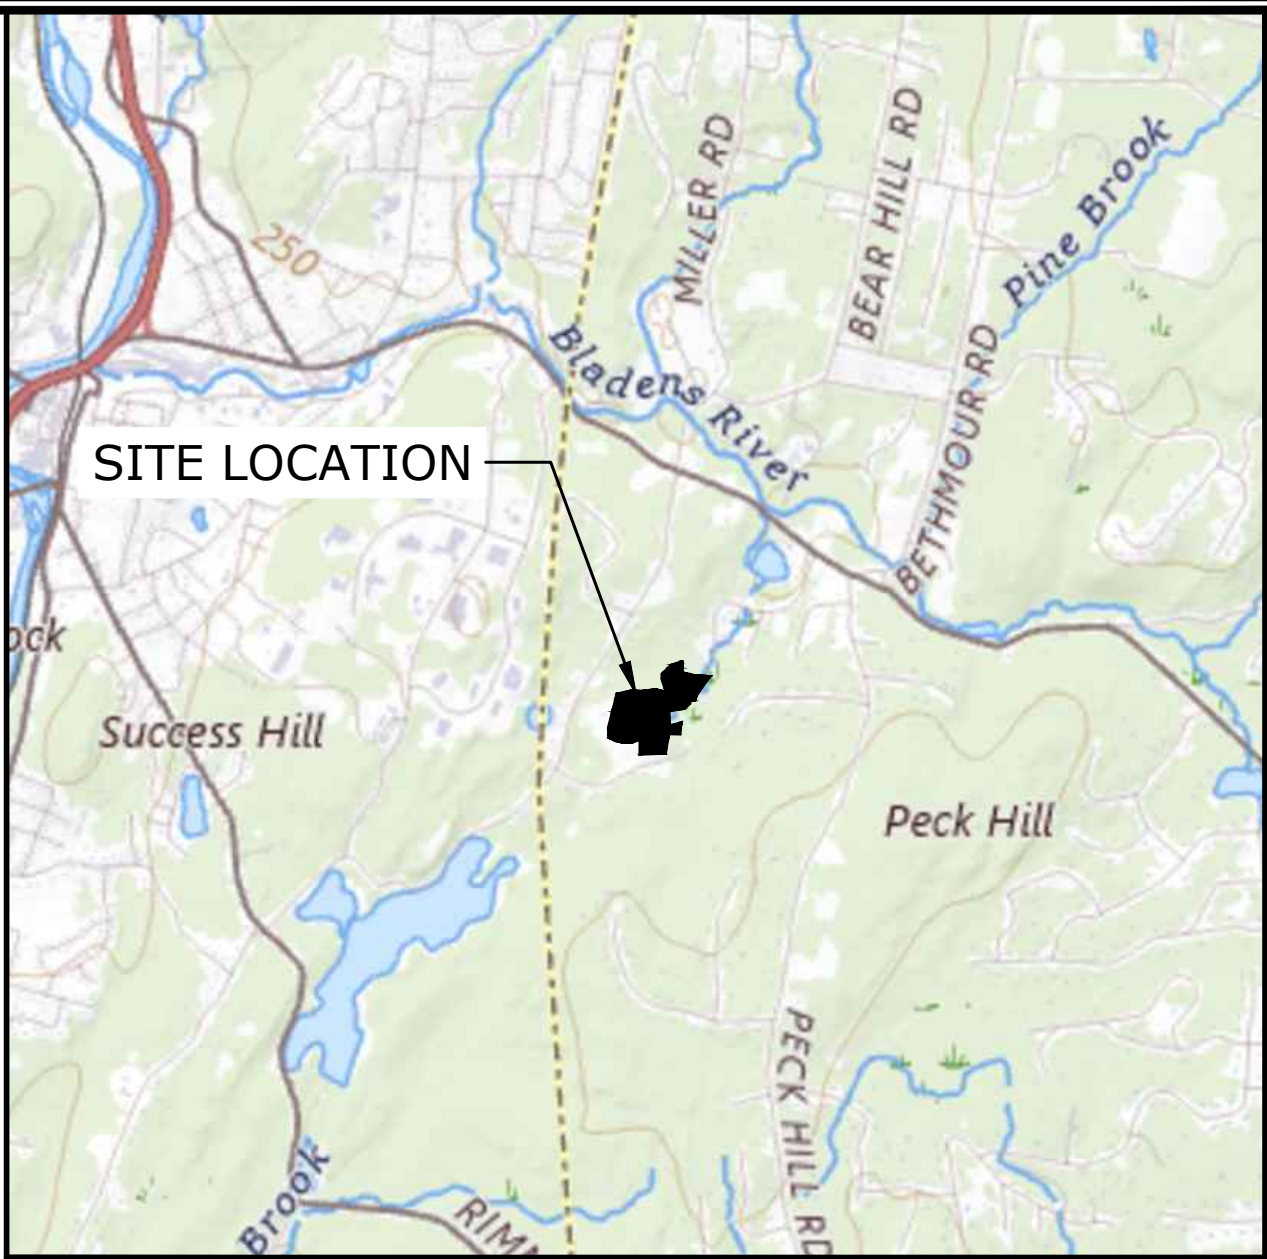

LOCATION MAP:

NTS

PREPARED FOR:



GREENSKIES CLEAN ENERGY, LLC
127 WASHINGTON AVENUE
WEST BUILDING - LOWER LEVEL
NORTH HAVEN, CONNECTICUT 06473


LIST OF DRAWINGS

NO.	NAME	TITLE
01	--	TITLE SHEET
02	LD	LEGEND & NOTES
03	IN	INDEX
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08-09	SE-1 & SE-2	SEDIMENT & EROSION CONTROL PLAN
10-11	SD-1 & SD-2	SITE DETAILS



Know what's below.
Call before you dig.
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PRELIMINARY 2/24/2025



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EXISTING CONDITIONS PLAN

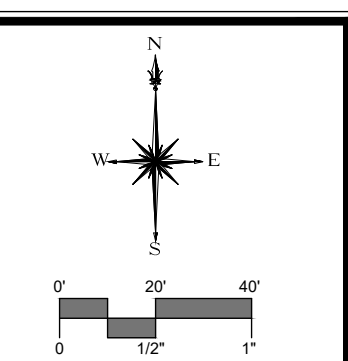**WOODBIDGE LANDFILL
GREENSKIES CLEAN ENERGY, LLC
ACORN HILL ROAD EXD.
WOODBIDGE, CONNECTICUT**

---	JLS	MRG
SIGNED	DRAWN	CHECKED
1"=40'		
FEBRUARY 24, 2025		
16763.00034		
05 OF 11		

EX-2

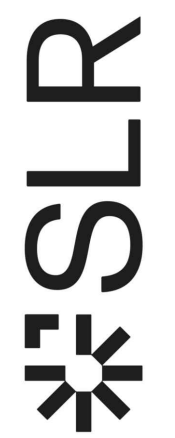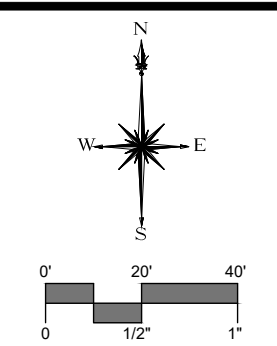

67 HUNT STREET, SUITE 203-C
AGAWAM, MA
413.241.6920
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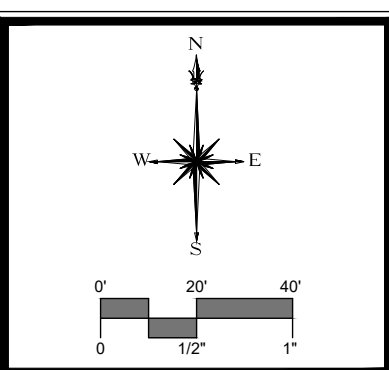
SITE LAYOUT & GRADING PLAN

**WOODBIDGE LANDFILL
GREENSKIES CLEAN ENERGY, LLC
ACORN HILL ROAD EXD.
WOODBIDGE, CONNECTICUT**

---	---	MRG
DESIGNED	DRAWN	CHECKED
1"=40'		
FEBRUARY 24, 2025		
DATE		
16763.00034		
PROJECT NO.		
07 OF 11		
SHEET NO.		

LA-2


SHEET NAME

[illegible]

SEDIMENT & EROSION CONTROL PLAN

**WOODBIDGE LANDFILL
GREENSKIES CLEAN ENERGY, LLC
ACORN HILL ROAD EXD.
WOODBIDGE, CONNECTICUT**

---	---	MRG
DESIGNED	DRAWN	CHECKED
1"=40'		
SCALE		
FEBRUARY 24, 2025		
DATE		
16763.00034		
PROJECT NO.		
09 OF 11		
SHEET NO.		
SE-2		
SHEET NAME		

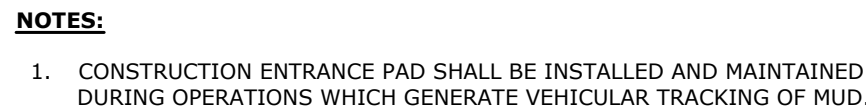

NOT TO SCALE



1. PROVIDE A MINIMUM TUBE DIAMETER OF 12 INCHES (300mm) FOR SLOPES UP TO 50 FEET (15.24m) IN LENGTH WITH A SLOPE RATIO OF 3H:1V OR STEEPER. LONGER SLOPES OF 3H:1V MAY REQUIRE LARGER TUBE DIAMETER OR ADDITIONAL COURSING OF FILTER TUBES TO CREATE A FILTER BERM. REFER TO MANUFACTURER'S RECOMMENDATIONS FOR SITUATIONS WITH LONGER OR STEEPER SLOPES.
2. INSTALL TUBES ALONG CONTOURS AND PERPENDICULAR TO SHEET OR CONCENTRATED FLOW.
3. TUBE LOCATION MAY BE SHIFTED TO ADJUST TO LANDSCAPE FEATURES, BUT SHALL PROTECT UNDISTURBED AREA AND VEGETATION TO MAXIMUM EXTENT POSSIBLE.
4. DO NOT INSTALL IN PERENNIAL, EPHEMERAL OR INTERMITTENT STREAMS.
5. ADDITIONAL TUBES SHALL BE USED AT THE DIRECTION OF THE ENGINEER.
6. ADDITIONAL SUPPORTS SHALL BE USED AT THE DIRECTION OF THE ENGINEER.

NOT TO SCALE



1. PREPARE SOIL BEFORE INSTALLING BLANKETS, INCLUDING APPLICATION OF LIME, FERTILIZER, AND SEED. EROSION CONTROL BLANKET SHALL BE NORTH AMERICAN GREEN ROLLMAX S150 OR APPROVED EQUIVALENT.
2. BEGIN AT THE TOP OF THE SLOPE BY ANCHORING THE BLANKET IN A 6" DEEP BY 6" WIDE TRENCH, BACKFILL AND COMPACT THE TRENCH AFTER STARTING.
3. ROLL THE BLANKETS DOWN THE SLOPE IN THE DIRECTION OF THE WATER FLOW.
4. THE EDGES OF PARALLEL BLANKETS MUST BE STAPLED WITH APPROXIMATELY 12" OVERLAP.
5. WHEN BLANKETS MUST BE SPLICED DOWN THE SLOPE, PLACE BLANKETS END OVER END (SHINGLE-STYLE) WITH APPROXIMATELY 6" OVERLAP, STAPLE THROUGH OVERLAP AREA, APPROXIMATELY 12" APART.

REFER TO GENERAL STAPLE PATTERN GUIDE IN NORTH AMERICAN GREEN
CATALOG FOR CORRECT STAPLE PATTERN RECOMMENDATIONS FOR SLOPE
INSTALLATIONS.

NOT TO SCALE

NOTES:


1. REMOVE EXISTING TOP SOIL DOWN TO EXISTING CAP. DO NOT PENETRATE CAP.
2. CONDUIT DEPTH IN COMPLIANCE WITH 2011 NEC TABLE 300.50 FOR 5KV CABLE.
3. USE CABLE RATED FOR WET LOCATIONS.
4. PROVIDE EXPLOSION PROOF FITTINGS FOR TRANSITIONS ABOVE GROUND.
5. ENCASE THE CONDUIT IN CONCRETE.
6. PROVIDE BERM IN ACCESS ROAD OVER CONCRETE ENCASED CONDUIT.

NOT TO SCALE



1. EXPANSION JOINTS EVERY 20LF MAXIMUM OR EVERY 144SF UNLESS OTHERWISE INDICATED ON PLANS (SEE JOINT DETAILS)
2. SCORE JOINTS 5' ON CENTER UNLESS OTHERWISE INDICATED ON PLANS.
3. USE AT LOADING DOCK AND ALL UTILITY PADS.

NOT TO SCALE

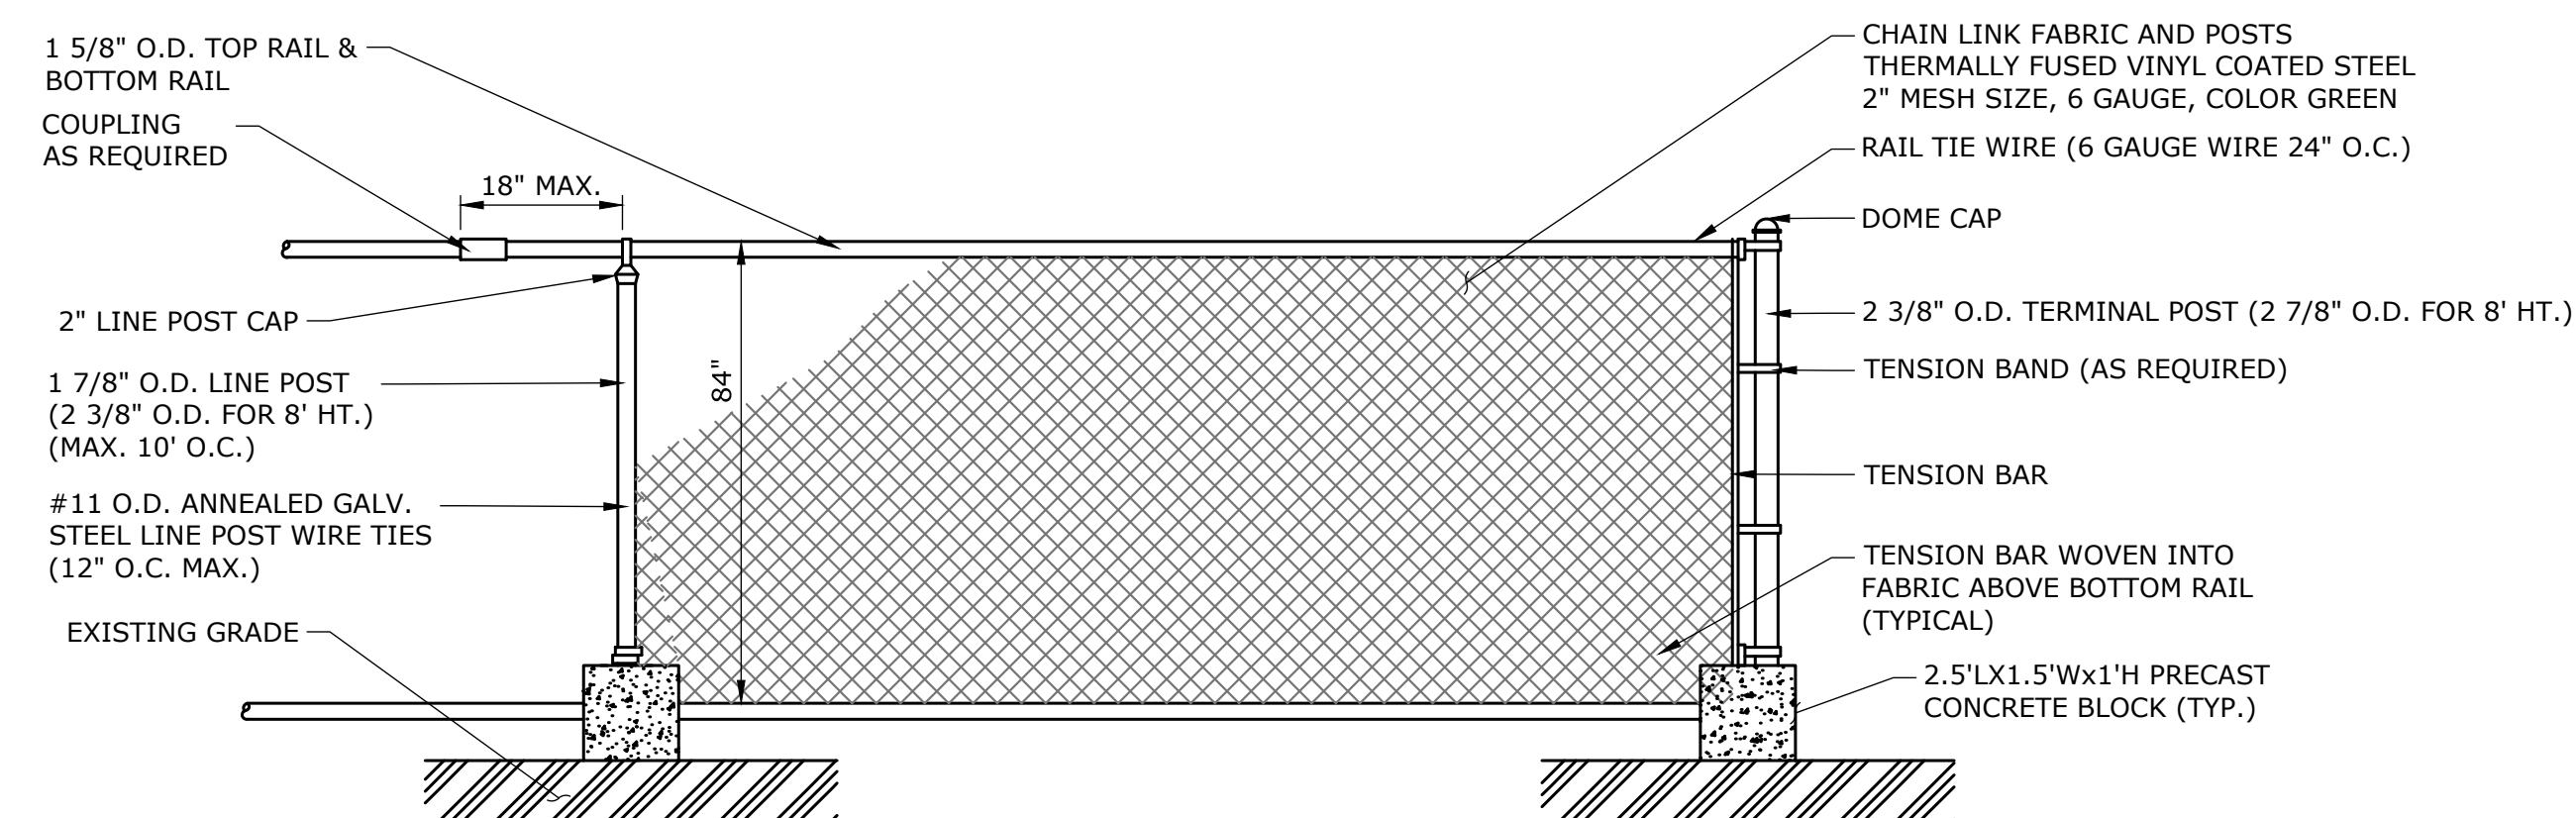


NOTES:

1. CONTRACTOR TO PROVIDE SHOP DRAWINGS

CHAIN LINK FENCE

NOT TO SCALE

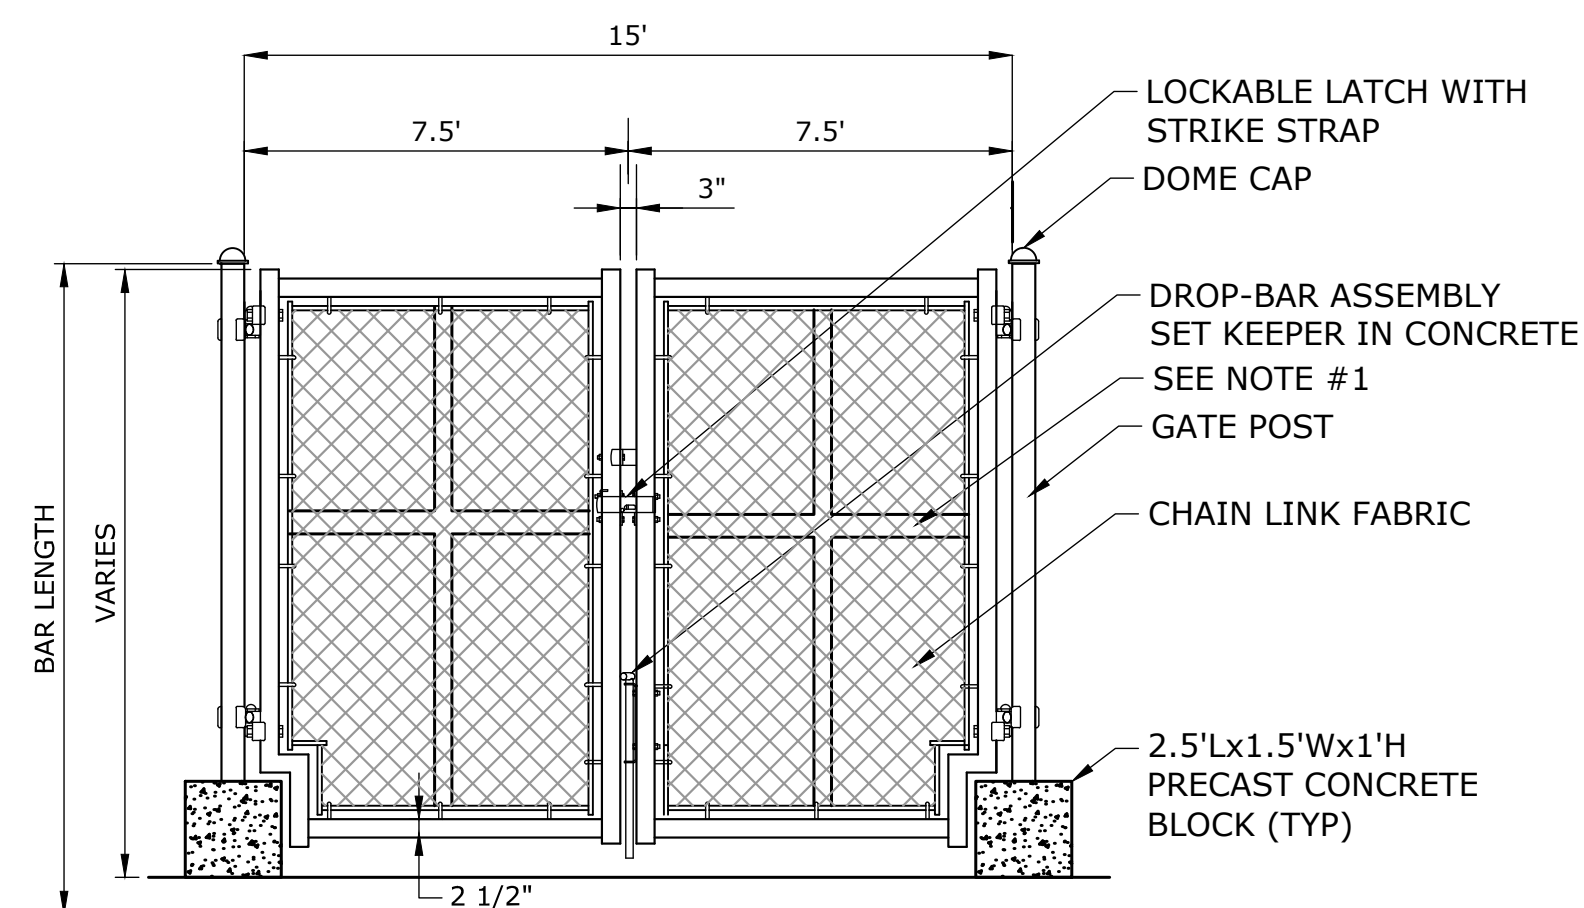

DOUBLE LEAF GATE		
OPENING	GATE POSTS	HINGE SPACE (S)
FACE TO FACE	SQ & RND SIZES	POST TO UPRIGHT
12'	2 7/8" OR 2.875" O.D.	FOR SQUARE & ROUND GATE POST: 2 7/8"

NOTES:

1. CENTER UPRIGS REQUIRED ON GATE LEAVES 8' & WIDER. CENTER RAIL REQUIRED ON GATE LEAVE 10' & HIGHER.
2. CONTRACTOR TO SUBMIT SHOP DRAWINGS.
3. ALL SWING GATES SHALL SWING AWAY FROM THE TRACK SURFACE, NO GATE SUBSIDING THE TRACK IS PERMITTED TO SWING TOWARDS THE TRACKS; PROVIDE STOP AS REQUIRED TO PREVENT SWINGING OF GATES TOWARDS THE TRACK.

DOUBLE CHAIN LINK FENCE GATE


NOT TO SCALE



NOTE: SIGN SHALL HAVE OVERALL DIMENSIONS OF 18" x 12"

NO TRESPASSING SIGN

NOT TO SCALE

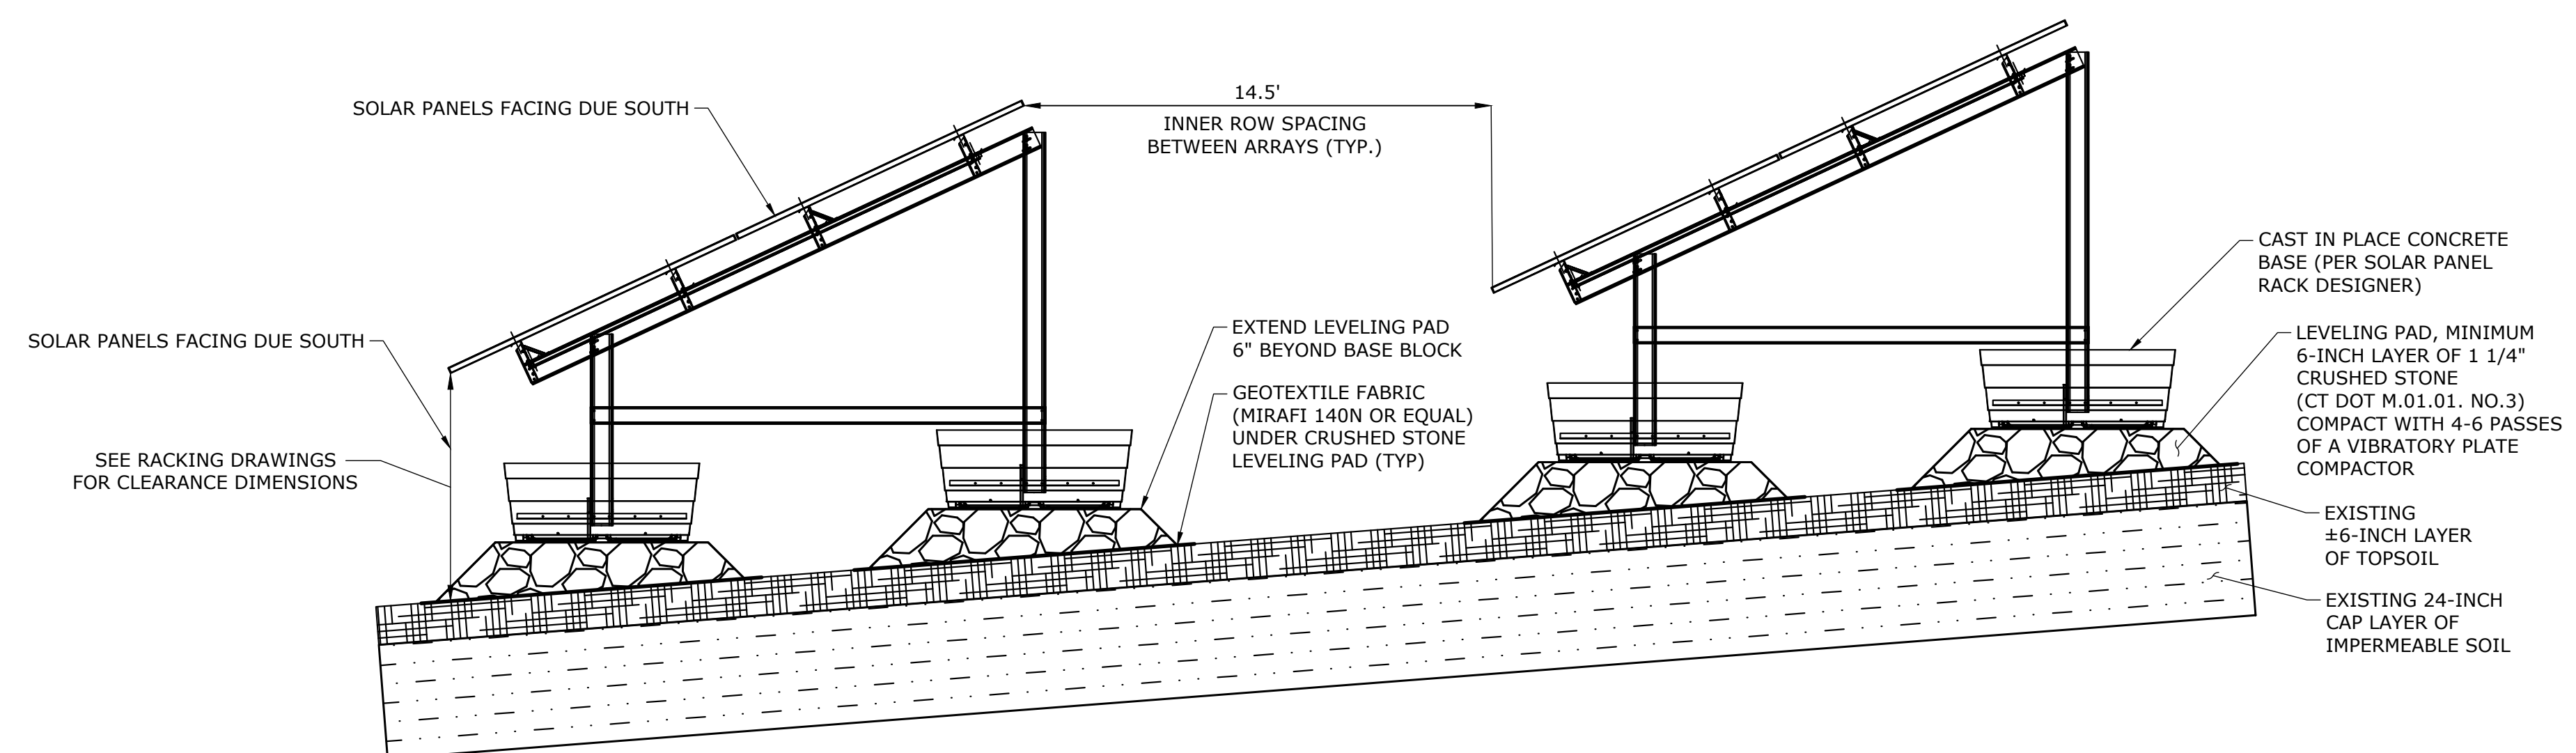

GROUND MOUNT SOLAR RACKING SYSTEM

NOT TO SCALE

WOODBRIDGE LANDFILL
GREENSKIES CLEAN ENERGY, LLC
ACORN HILL ROAD EXD.
WOODBRIDGE, CONNECTICUT

MRG DESIGNED	JLS DRAWN	MRG CHECKED
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AS NOTED

FEBRUARY 24, 2025

16763.00034

11 OF 11

SD-2